



West Pennsboro
Township
2150 Newville Road
Carlisle, PA 17015
(717) 243-8220

TOWNSHIP USE ONLY
STORM WATER NO: _____
PARCEL NO: _____

APPLICATION FOR A STORM WATER MANAGEMENT PERMIT

Application is hereby made to West Pennsboro Township for the issuance of a Storm Water Management Permit pursuant to the specifications herewith submitted.

Fee Amount: _____ 0 to 1,000 SQ. FT. = **No Fee/Exempt from providing a Storm Water Plan**
 _____ 1,001 to 5,000 SQ. FT. = **\$350.00 (includes Administrative and Engineer's fees *)**
 _____ 5,000 to 20,000 SQ. FT. = **\$650.00 (includes Administrative and Engineer's fees *)**

*Engineer's fees assumes one (1) review and one (1) inspection. Additional reviews and inspections as required will be charged in addition to these fees.

1. **Name of Property Owner(s):** _____
Address: _____
Phone: _____ **Email:** _____

2. **Storm Water Management Plan Prepared By:** _____
Address: _____
Phone: _____ **Email:** _____ **Fax:** _____

For single family residential projects proposing less than 7,500 sq. ft. of impervious area, or agricultural uses proposing less than 10,000 sq. ft. of impervious area, applicant may elect to use standardized infiltration bed or bioretention area details (see attached) in lieu of an individual design. Applicant must submit site sketch showing location of proposed drainage facilities.

3. **Project Location:** _____
 4. **Description of Work to be Performed:** _____

Include amount of Impervious Area (including gravel) to **determine the Fee above:**

Structure(s): _____ sq. ft. Driveway: _____ sq. ft. Sidewalks: _____ sq. ft.
 Parking Area: _____ sq. ft. Patio area: _____ sq. ft. Other: _____ sq. ft.

Total Sq.Ft.: _____


5. **Is the total area of Earth Disturbance greater than 1 Acre (43,560 sq. ft.)?**
 _____ No _____ Yes (If yes, NPDES Permit is required)
6. **If the property is the subject of a subdivision or land development, provide plan book record number or Township identification number.** _____
7. **Attach Storm Water Management Plan Report & Site Plan.**

The undersigned hereby represents that, to the best of their knowledge and belief, all information listed above and on the attached is true, correct, and complete and in accordance with West Pennsboro Township's Stormwater Management Ordinance.

TOWNSHIP USE ONLY

DENIED: _____ APPROVED AS SUBMITTED: _____ APPROVED with CONDITIONS: _____


TOWNSHIP ISSUING AUTHORITY: _____ DATE: _____

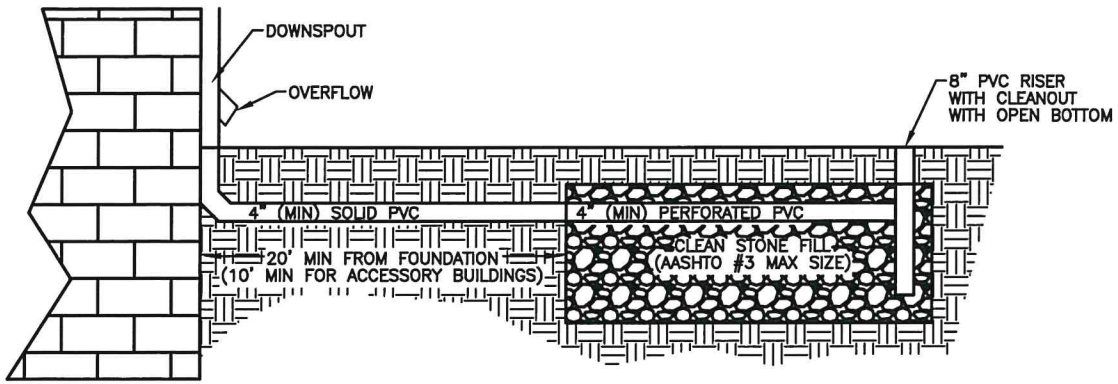

1. Bottom of 8" riser to be 8" clear of bottom of infiltration bed.
2. Stone to be lined with barrier fabric to prevent soil intrusion into stone.
3. Top of stone shall be 12" below grade. If owner desires the stone to be exposed, barrier fabric should still be placed on the top, below a 1"-2" layer of stone.
4. Landscape fabric is an example of an acceptable barrier fabric.
5. Provide 40 cubic feet of stone for every 100 square feet of impervious area. All roof drains shall be connected to an infiltration bed. Driveways shall be pitched to allow runoff to drain to an infiltration bed.
6. Minimum stone size is AASHTO #57. Maximum stone size is AASHTO #3. Stone must be clean.

TYPICAL ROOF AND DRIVEWAY INFILTRATION BED

NOT TO SCALE

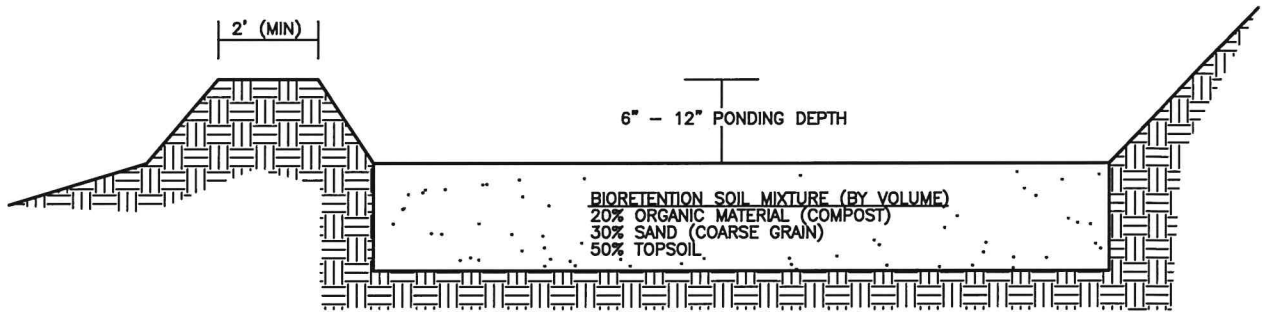

1. 1#/1000 square feet of Riverbank Wild Rye Grass (*Elymus Riparius*) or 1#/1000 square feet of Virginia Wild Rye Grass (*Elymus Virginicus*) shall be mixed with normal lawn seeding mixtures.
2. Other native water tolerant grasses, shrubs, and trees may also be used.
3. Scarify existing soil prior to placement of soil mixture. Place soil mixture directly onto existing scarified soil. Depth of soil mixture shall be 12".
4. Provide 25 square feet of bioretention area for every 100 square feet of impervious area. Direct runoff from impervious areas to bioretention areas through roof drains or site grading.

TYPICAL BIORETENTION AREA

NOT TO SCALE



STORMWATER DETAILS
WEST PENNSBORO TOWNSHIP
2150 NEWVILLE ROAD
CARLISLE, PA 17015

DATE: 08/12/2020

DRAWING NUMBER **1**

FILE: WPT DETAILS

TOTAL DRAWINGS **1**

SCALE: NOT TO SCALE

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